




REAR ELEVATION

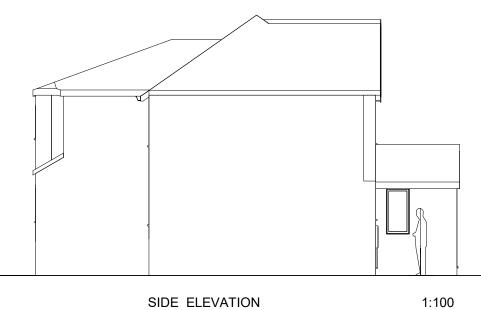

Α CHARTERED PRACTICE


PROPOSED ELEVATIONS






Project: 54 Sapperton Road Client: Mr & Mrs Wild Drawing: Proposed Elevations Drawn By Lloyd Gordon Date: 14/07/2022 Scale: 1:100 @A3 Revision: 1

4

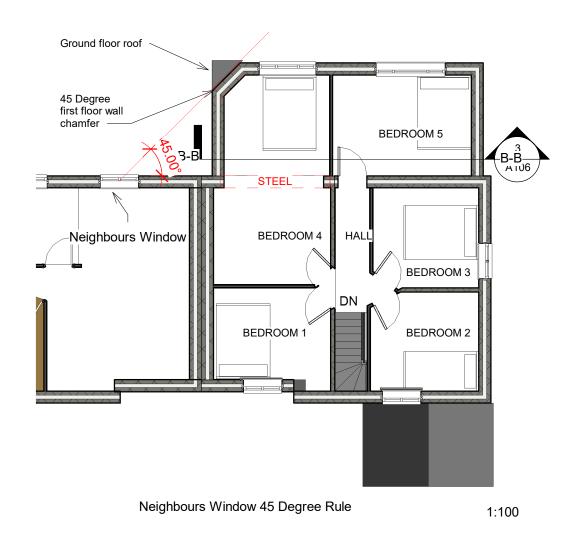


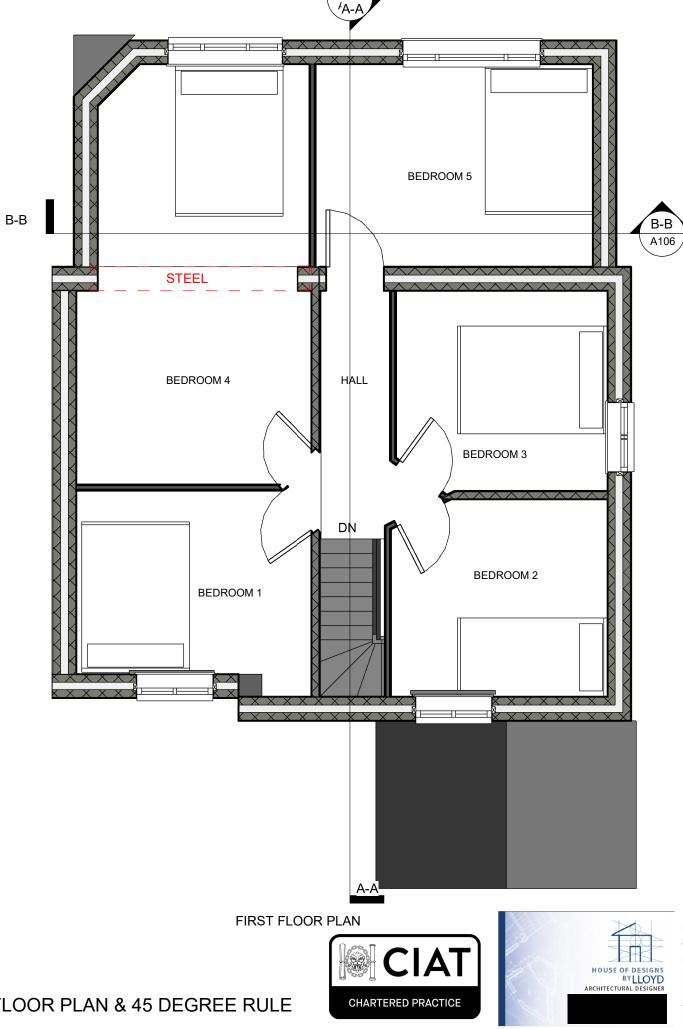

PROPOSED FIRST FLOOR PLAN & 45 DEGREE RULE

1:50

Project: 54 Sapperton Road Client: Mr & Mrs Wild Drawing: Proposed First Floor Plan Drawn By Lloyd Gordon Date: 14/07/2022 Scale: 1:50,1:100 @A3 Revision: 1

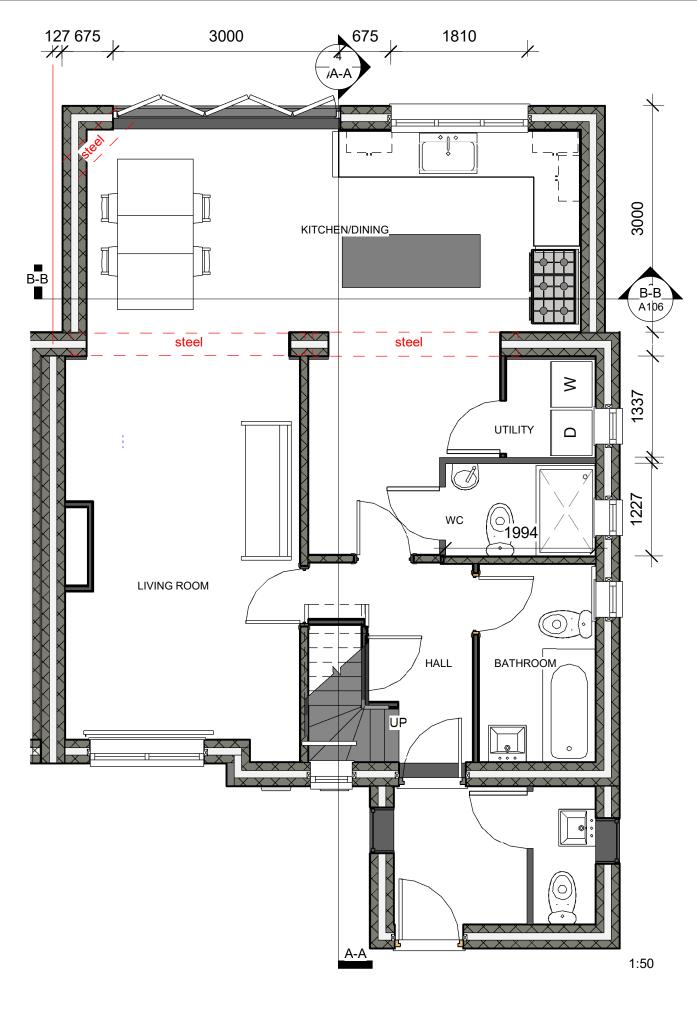

PROPOSED GROUND FLOOR PLAN

Notes:

Severntrent build-over application required if construction within 3 metres of a shared drain

Building Regulations application required before works start

materials

Structural Engineers Calculations and Design Required Roof design & Steel Supports

Specification:

300mm wide cavity wall with 100mm cavity wall rock wool insulation Batts to BS 6676

cavity wall ties positioned max 450mm vertical, 900mm horizontal to BS EN 845-1

Damp proof course laid level with existing floor level to BS EN 14909

Damp proof tray laid to BS 8215

Ground floor spec-(1) 100mm Hardcore (2) 100mm compacted tight one stone (3) 20mm sand binding (4) Damp proof membrane BS EN 13967: 2012. (5) 100mm rigid insulation BS 5241-1:1994 (6) separation layer (7) 100mm concrete floor (8) floor finish to be confirmed by client



Proposed Not to protrude the boundary

All Dimensions are to be checked on site

All proposed materials to match existing

Wall starter Ties fixed to existing external wall to BS EN10088-2

Cavity wall closures positioned at windows and doors to BS EN ISO 9001

Fascia/Soffit: 19mm Upvc with 25mm continuous ventilation



Project: 54 Sapperton Road Client: Mr & Mrs Wild Drawing: Proposed Ground Floor Plan Drawn By Lloyd Gordon Date: 14/07/2022 Scale: 1:50, @A3 Revision: 1



RENDER OF REAR



3D SKETCH OF REAR



KITCHEN RENDER



PROPOSED RENDERS



Project: 54 Sapperton Road Client: Mr & Mrs Wild Drawing: Proposed Renders Drawn By Lloyd Gordon Date: 14/07/2022 Scale: @A3 Revision: 1