

1:200


OSBORNESCHARTEREDARCHITECTS

CLIENT MR IAIN WALL PROJECT 101 RESERVOIR ROAD TITLE SITE SECTION

SCALE 1:200 @ A2 DATE AUG 2021

DRAWN TL /AML DRAWING NUMBER 21-111-S1B

- 1. Do not scale from this print or use as a template.
- All dimensions must be verified on site before any work is put in hand and any discrepancies must be reported to the Architect. Where any variations occur between small scale and detailed drawings, detail drawings should be worked from.
- Copyright of this drawing is reserved by Osbornes and is issued on condition that it is not copied or disclosed to any third party either wholly or in part without the consent of Osbornes in writing.

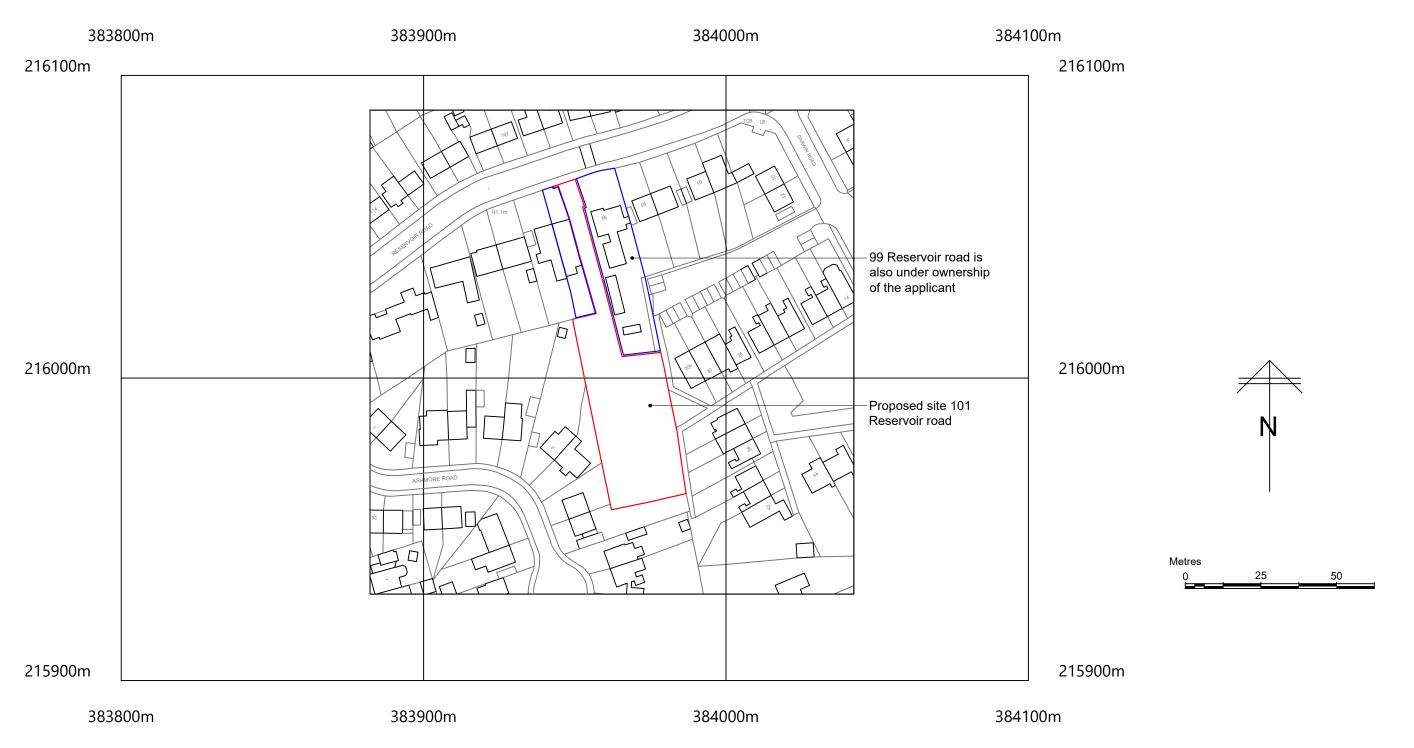


©Crown Copyright and database rights 2021 OS Licence no. 100019311


REV C: 08/12/2022 Outlines updated OSBORNESCHARTEREDARCHITECTS

CLIENT MR IAIN WALL
PROJECT 101 RESERVOIR ROAD
TITLE LOCATION PLAN
SCALE 1:1250 @ A3
DATE AUG 2021

- 1. Do not scale from this print or use as a template.
- All dimensions must be verified on site before any work is put in hand and any discrepancies must be reported to the Architect. Where any variations occur between small scale and detailed drawings, detail drawings should be worked from.
- Copyright of this drawing is reserved by Osbornes and is issued on condition that it is not copied or disclosed to any third party either wholly or in part without the consent of Osbornes in writing.

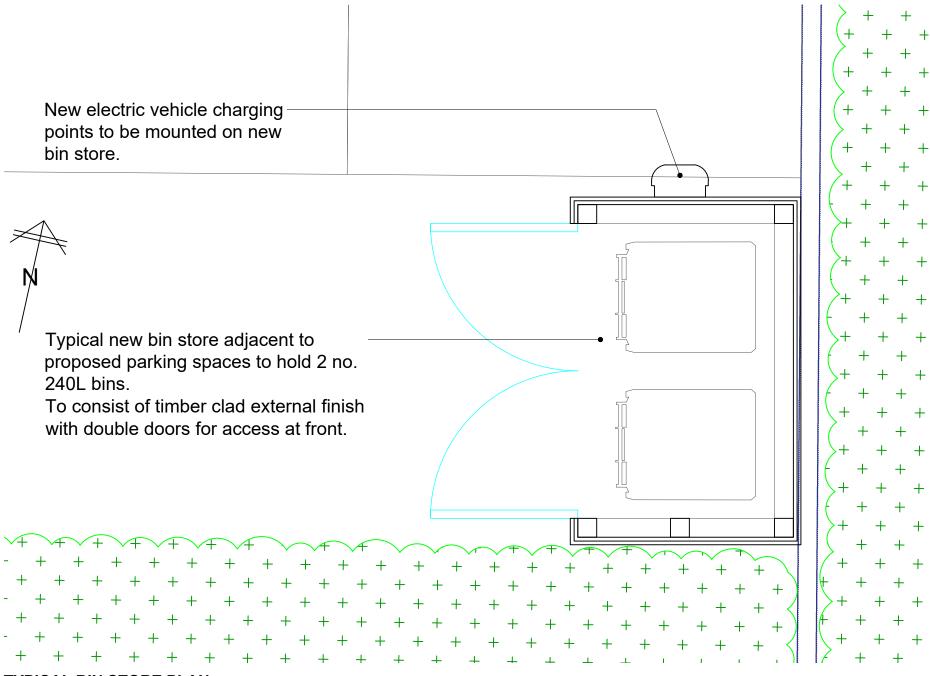

TYPICAL BIN STORE PLAN

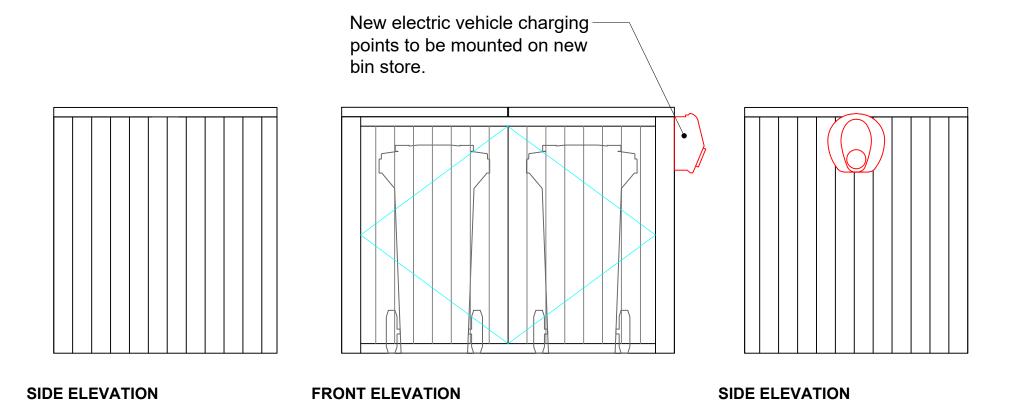

Millimetres
0 200 400 600 800 1000

REV A: 30/11/2022 Scale bar added

OSRORNESCHARTERED ARCHITECTS


CLIENT MR IAIN WALL

PROJECT 101 RESERVOIR ROAD

TITLE TYPICAL PROPOSED BIN STORE PLAN

SCALE 1:20 @ A3
DATE NOV 2022

DRAWN TL DRAWING NUMBER 21-111-GA4A

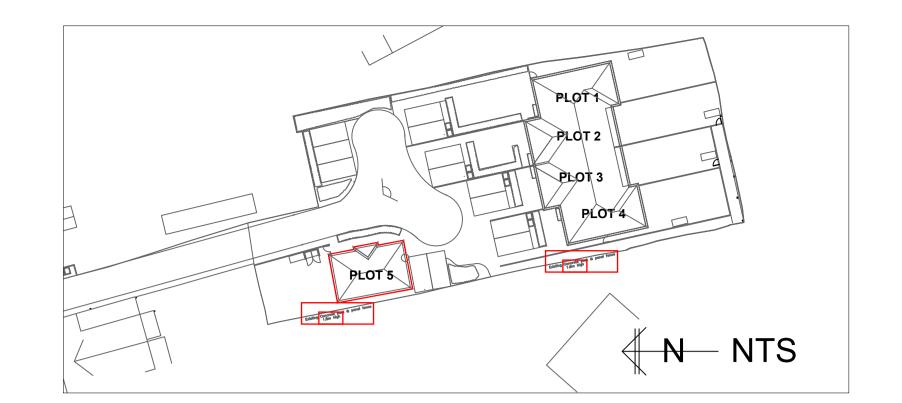


- Do not scale from this print or use as a template.
 All dimensions must be verified on site before any work is put in hand and any discrepancies must be reported to the Architect. Where any variations occur between
- small scale and detailed drawings, detail drawings should be worked from.

 3. Copyright of this drawing is reserved by Osbornes and is issued on condition that it is not copied or disclosed to any third party either wholly or in part without the consent of Osbornes in writing.






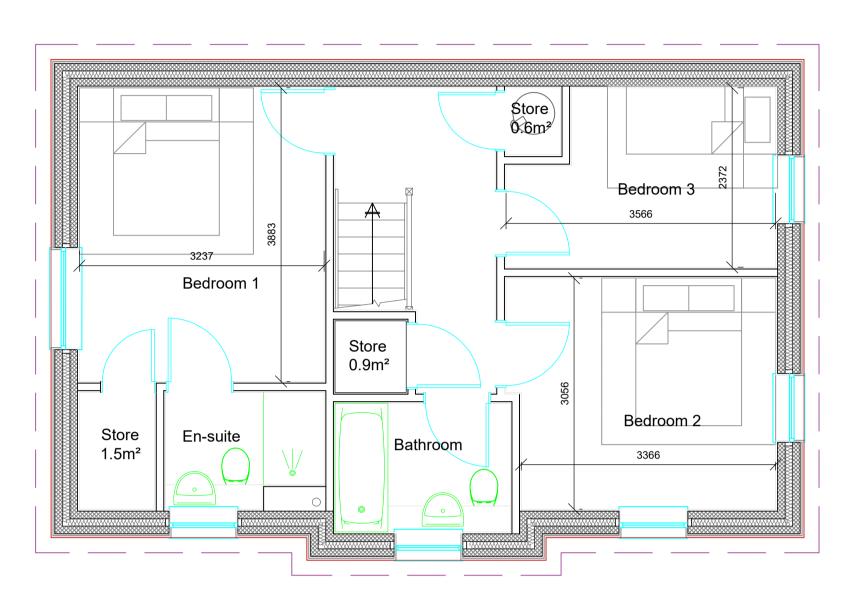

NORTH ELEVATION - SIDE


WEST ELEVATION - REAR

EAST ELEVATION - FRONT

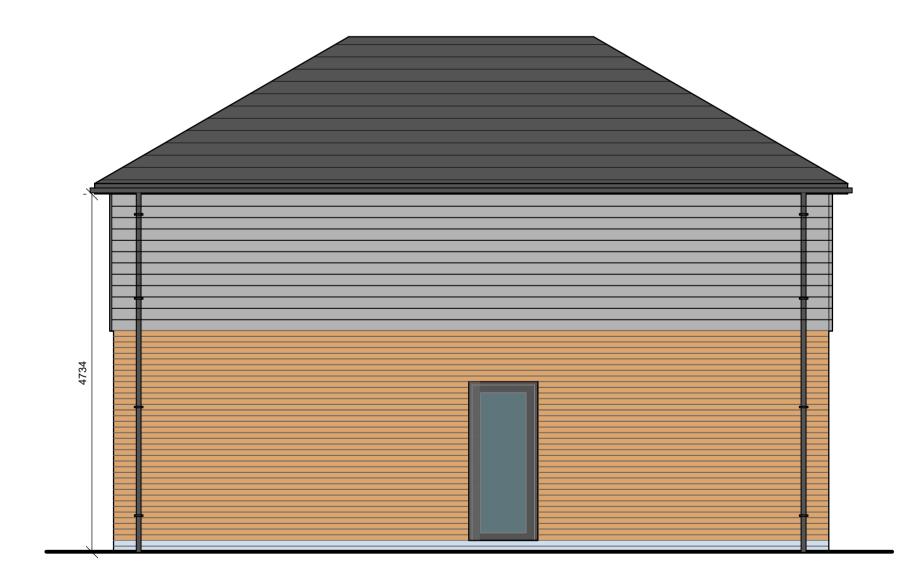



SOUTH ELEVATION - SIDE

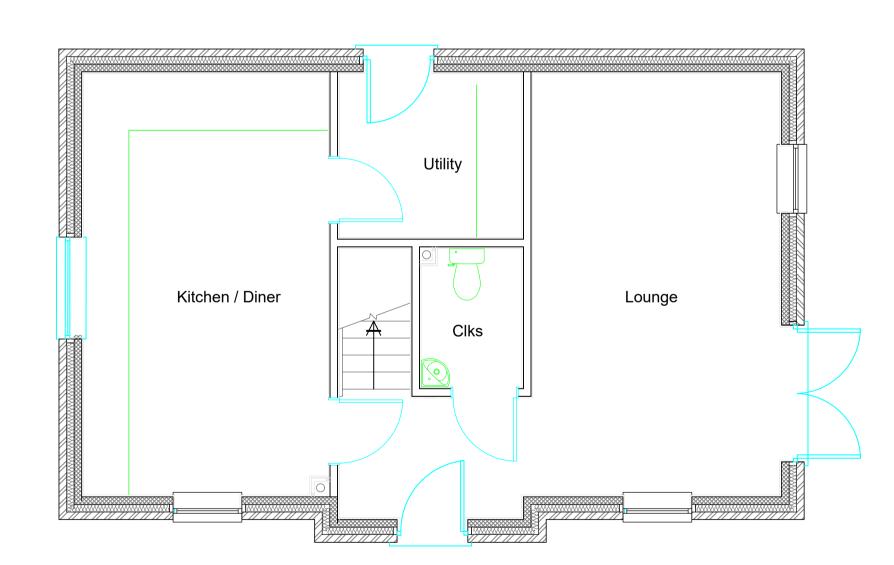

REV E: 08/12/2022 Additional dimensions added REV D: 30/11/2022 Additional dimensions added REV C: 25/10/2022 Design altered.

OSBORNESCHARTEREDARCHITECTS

CLIENT MR IAIN WALL


PROJECT 101 RESERVOIR ROAD


TITLE PLOTS 5 PROPOSED PLANS AND ELEVATIONS

SCALE 1:50 @ A1

DATE AUG 2021


DRAWN TL / AML DRAWING NUMBER 21-111-GA3E

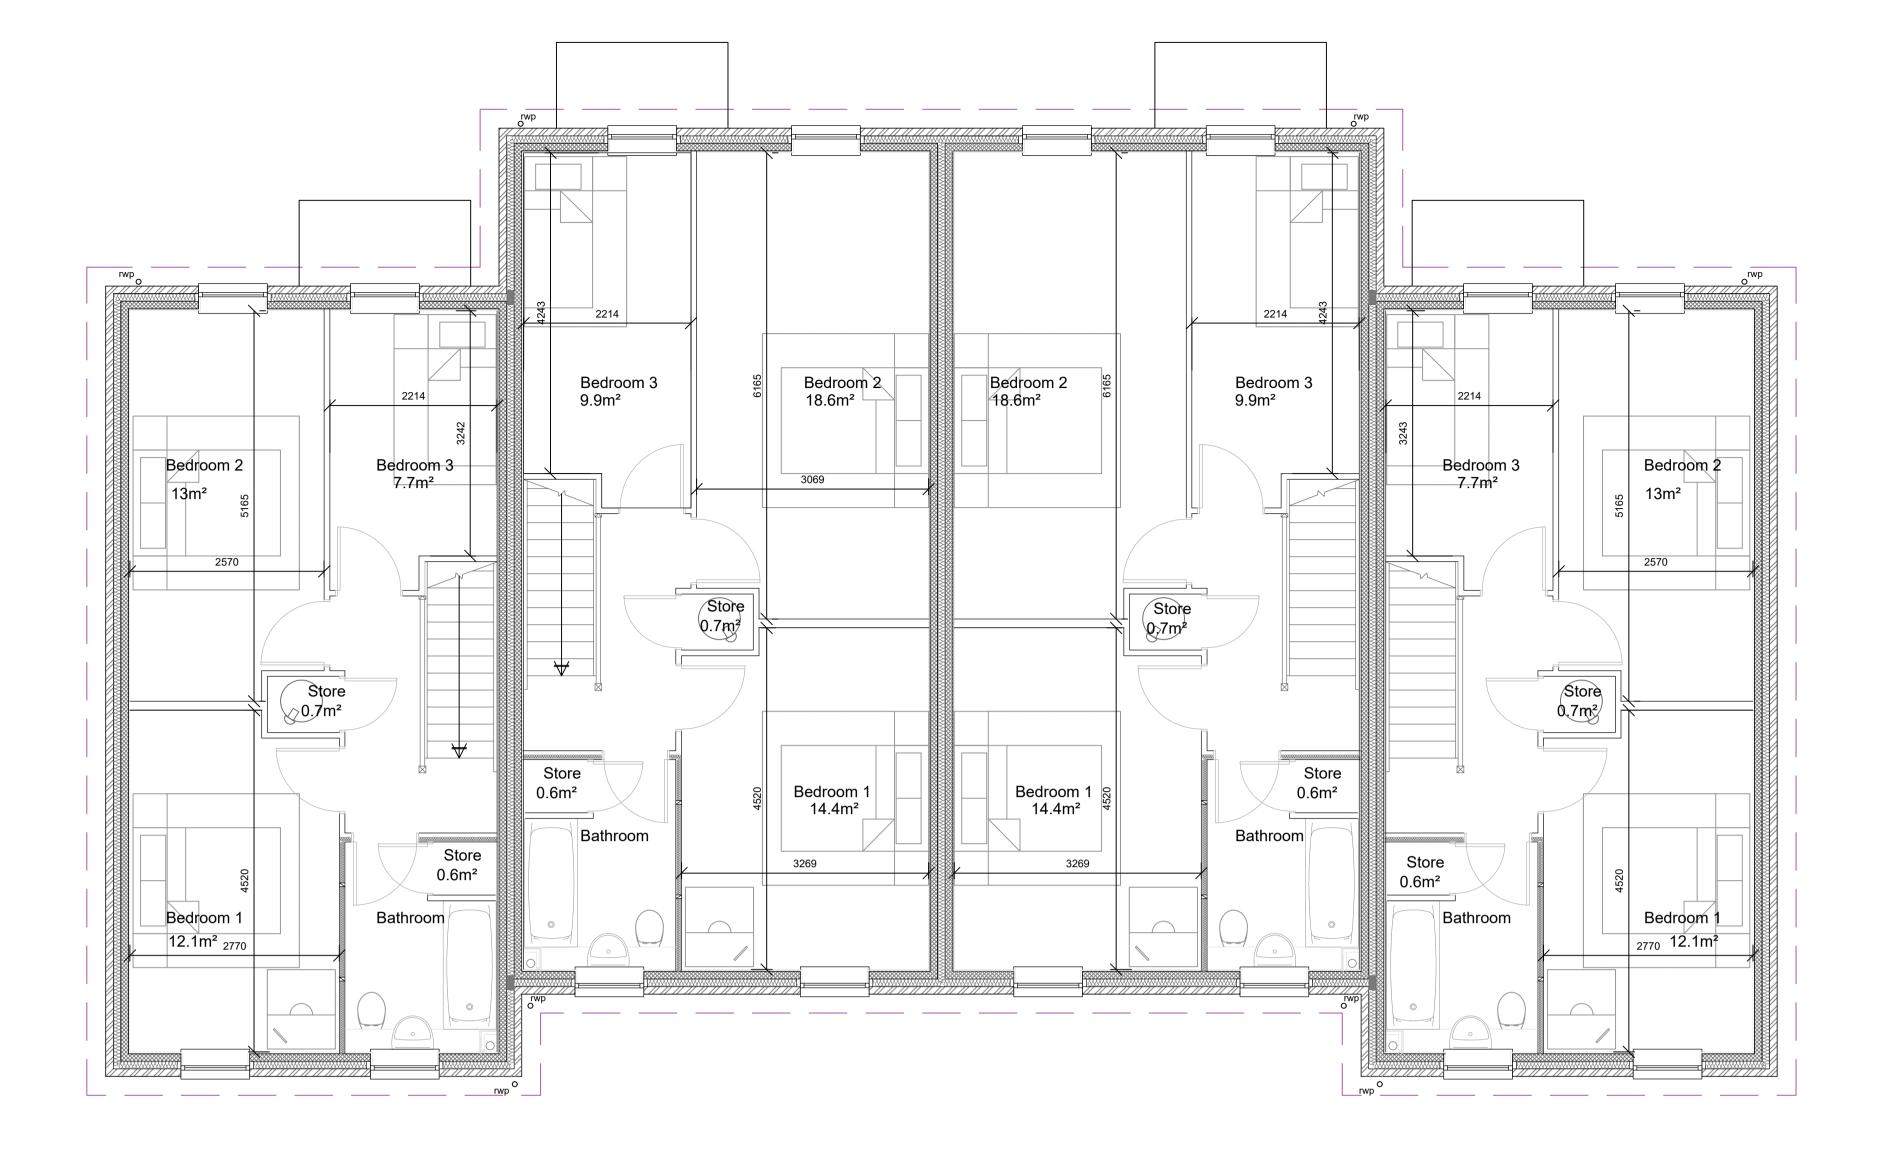

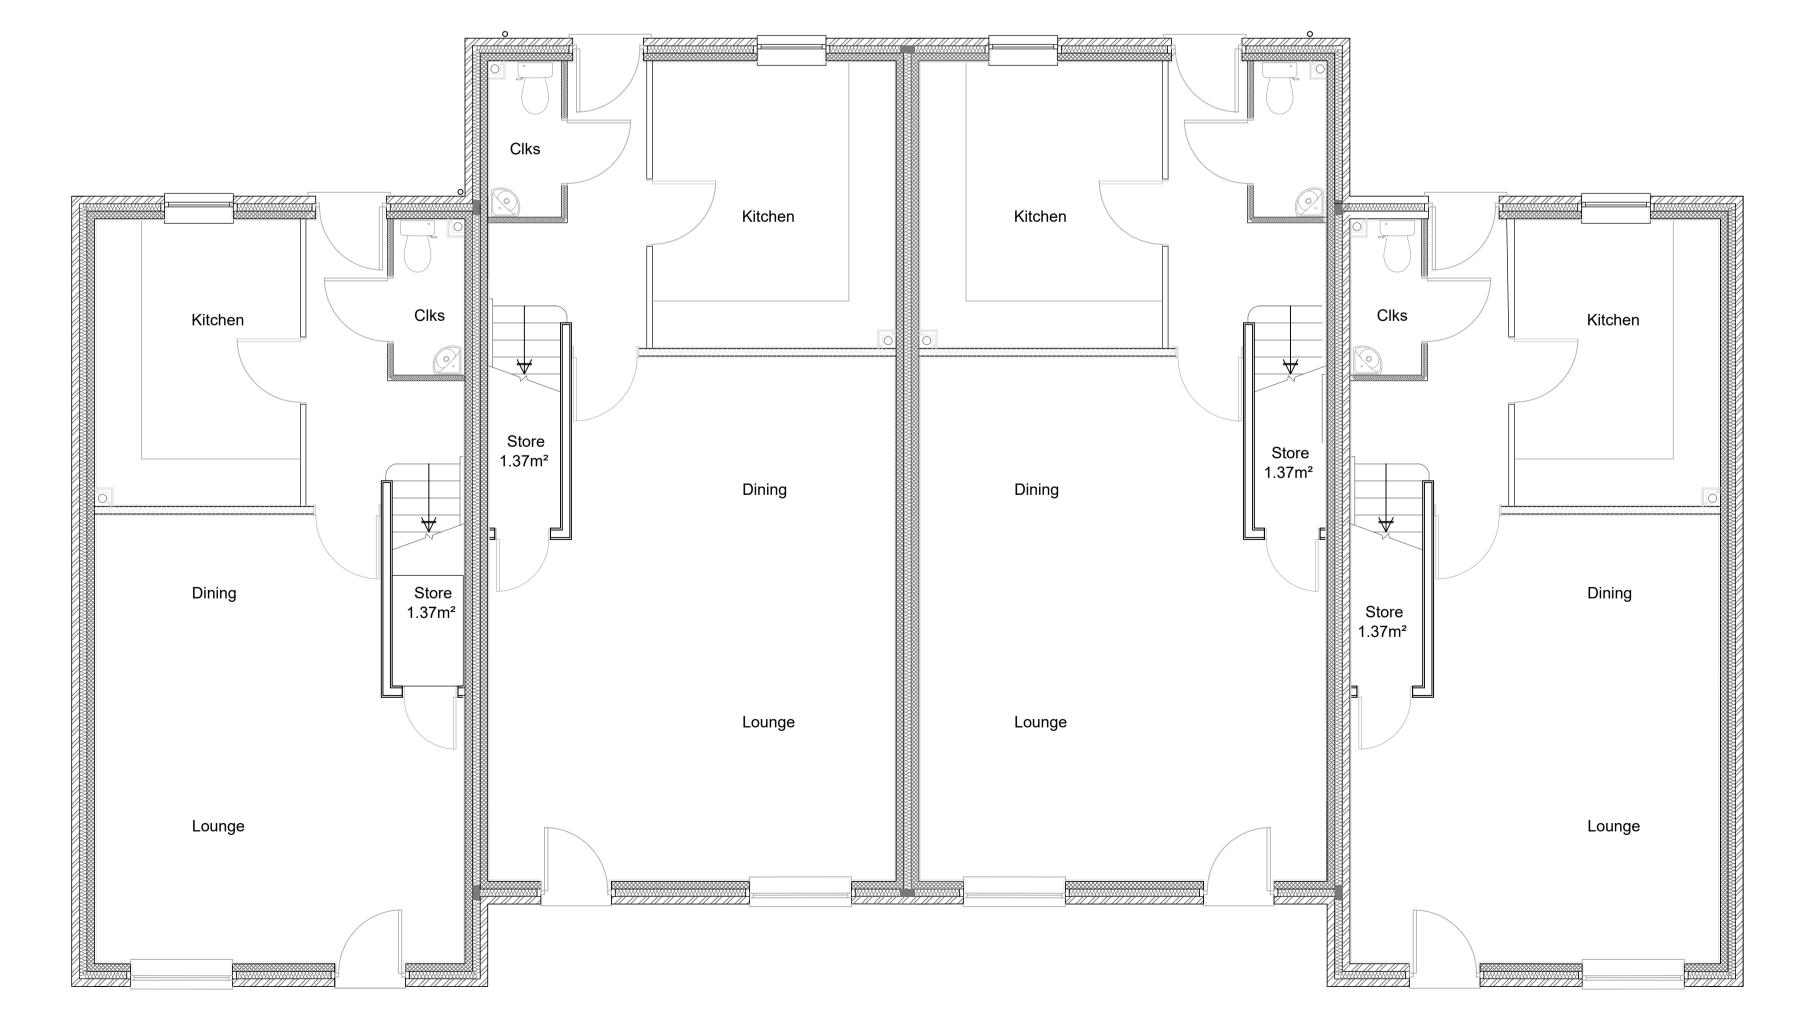

- Do not scale from this print or use as a template.
 All dimensions must be verified on site before any work is put in hand and any discrepancies must be reported to the Architect. Where any variations occur between
- small scale and detailed drawings, detail drawings should be worked from.

 3. Copyright of this drawing is reserved by Osbornes and is issued on condition that it is not copied or disclosed to any third party either wholly or in part without the consent of Osbornes in writing.

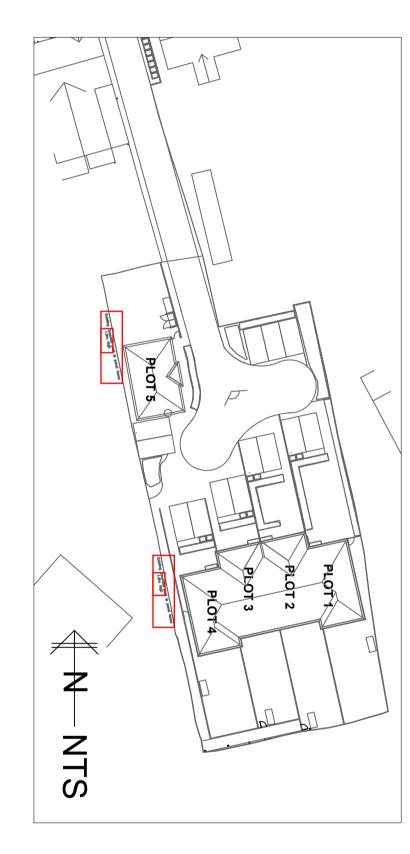

REV B: 30/11/2022 Additional dimensions added REV A: 25/10/2022 Altered from semi detached to terrace.

CLIENT MR IAIN WALL


PROJECT 101 RESERVOIR ROAD

TITLE PLOTS 1-4 PROPOSED ELEVATIONS **SCALE** 1:50 @ A1

DATE AUG 2021

DRAWN TL/AML DRAWING NUMBER 21-111-GA2B



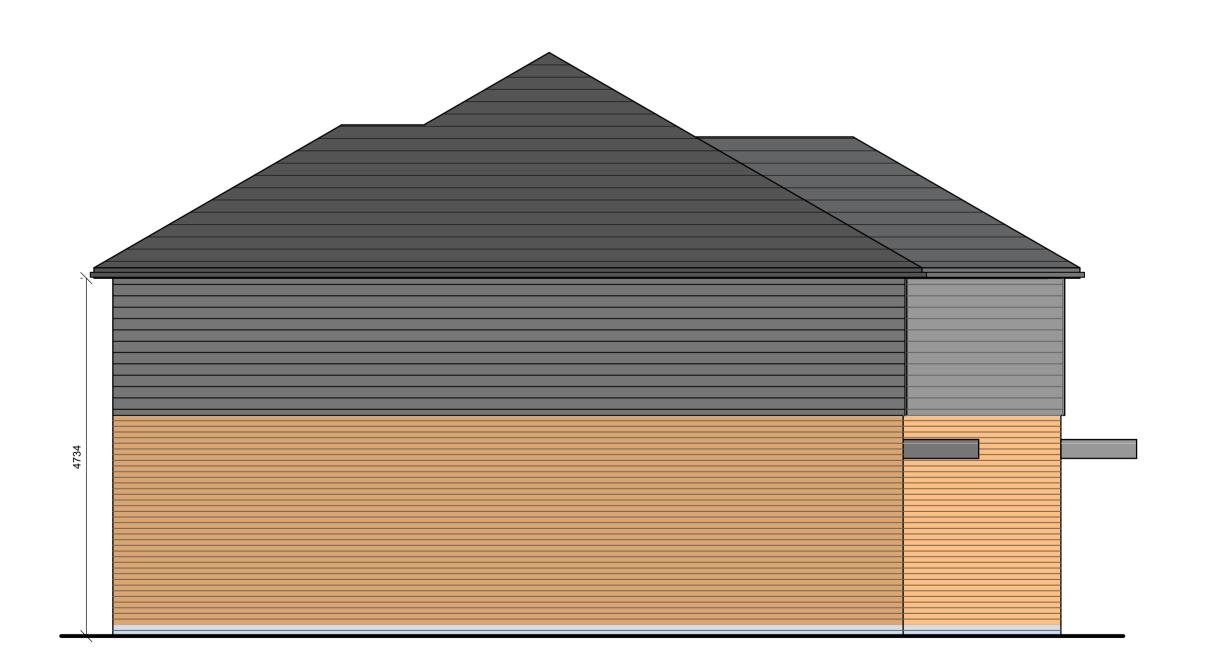





PLOT 1

SOUTH ELEVATION - REAR

Materials

External Walls - Wienerberger Mozart Blend 65mm. staffordshire blue brindle smooth 65mm. Cladding - Cedral Composite Cladding - Grey.

Roof - Marley Duo Plain Tile, smooth grey.

Windows - UPVC in Grey.

Fascia/soffit - Grey.

REV E: 30/11/2022 Roof altered REV D: 25/10/2022 Altered from semi detached to terrace.

OSBORNESCHARTEREDARCHITECTS

CLIENT MR IAIN WALL

PROJECT 101 RESERVOIR ROAD


TITLE PLOTS 1-4 PROPOSED ELEVATIONS

SCALE 1:50 @ A1 DATE AUG 2021

GENERAL NOTES

DRAWN TL DRAWING NUMBER 21-111-GA1E


- 1. Do not scale from this print or use as a template.
- All dimensions must be verified on site before any work is put in hand and any discrepancies must be reported to the Architect. Where any variations occur between small scale and detailed drawings, detail drawings should be worked from.
- Copyright of this drawing is reserved by Osbornes and is issued on condition that it is not copied or disclosed to any third party either wholly or in part without the consent of Osbornes in writing.

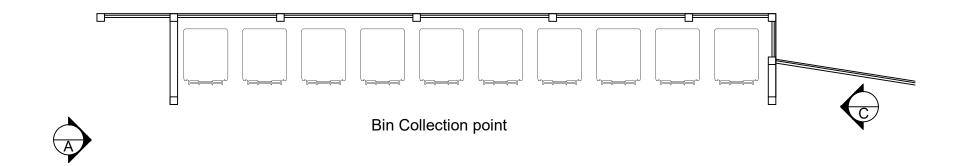






PROPOSED BIN COLLECTION POINT

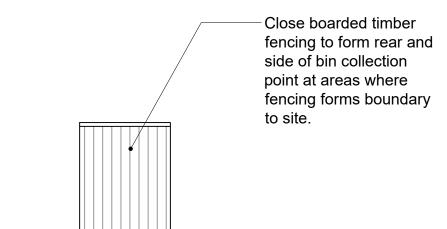

Hit and miss timber fencing to form enclosure to bin collection point.

PROPOSED ELEVATION A

PROPOSED ELEVATION C

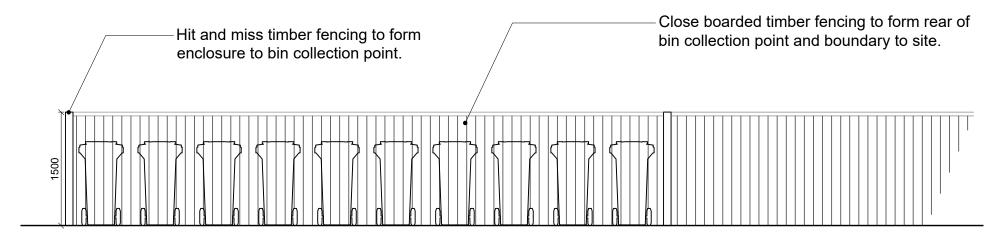

PROPOSED ELEVATION B

Metres 2 2

REV B: 08/12/2022 Notes updated

OSBORNES CHARTERED ARCHITECTS

CLIENT MR IAIN WALL

PROJECT 101 RESERVOIR ROAD

TITLE PROPOSED BIN COLLECION POINT DETAILS

SCALE 1:50 @ A3

DATE NOV 2022 DRAWN TL

DRAWING NUMBER 21-111-E2B